

Drawing Examples


www.jcplans.com

07565 788821

johnjcplans@gmail.com

Dwg No: 02P - Proposed Floorplan Elevations

Notes

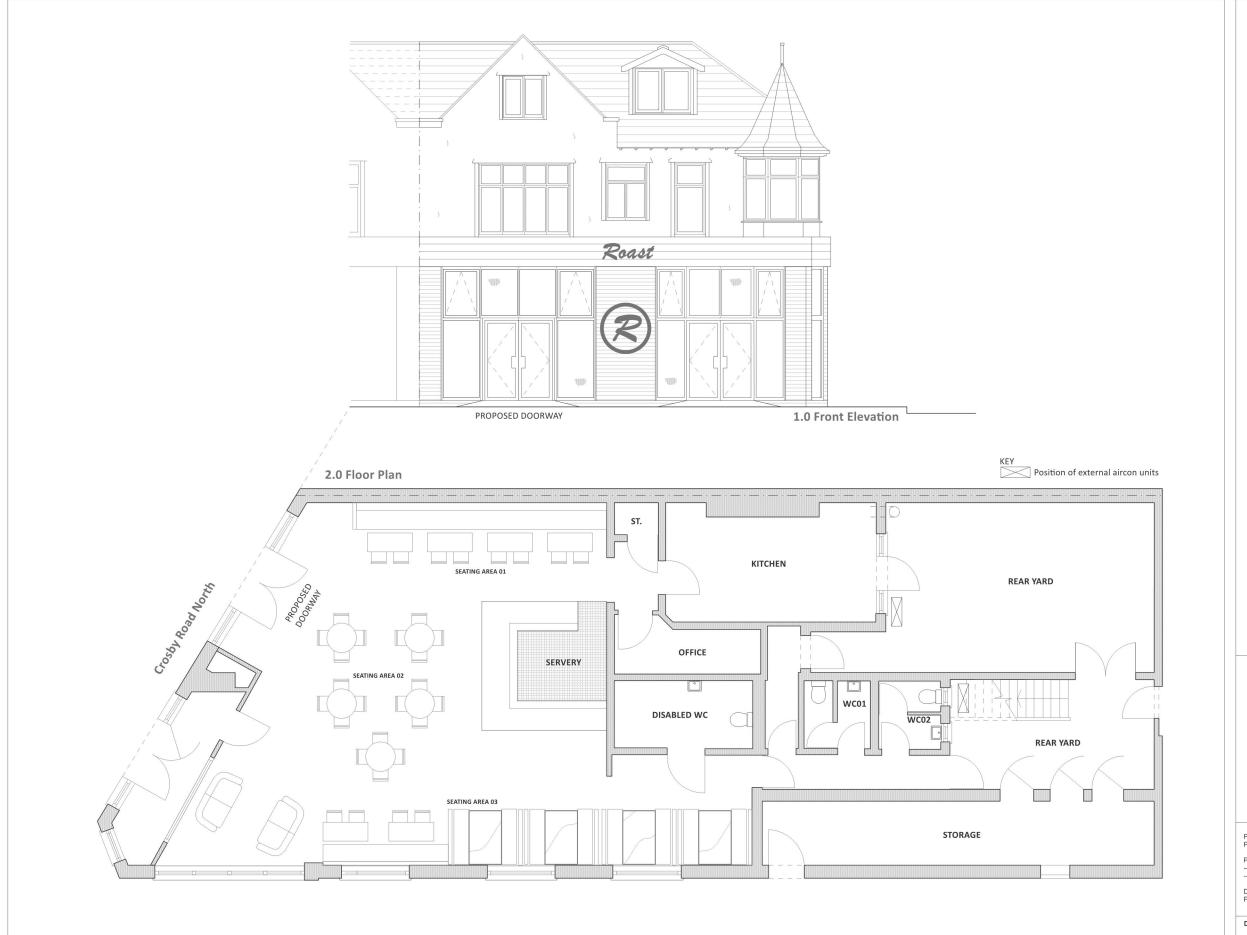



Scale: 1:100 @

A3

Dwg No: 01P - Existing Elevations





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MATERIALS/ FINISHES

[1] Elevations - brick. Rendering is present to the rear elevation of the outrigger.

[2] Windows/ fenestrations - Windows: uPVC & double glazed. Doors: timber.

[3] Lean-to - Roof: polycarbonate sheets supporting on timber with plywood boarding.

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Drawn: JC	Date	Revisions	Scale: 1:100 @
Drawing Title Existing Elevations	c .		Drawing Number
Project/ Client			
PLÁNNING DRAW	ING		294-AB
Project Status			Job Number

Dwg No: 02P - Proposed Elevations





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MATERIALS/ FINISHES

[1] Side Elevation - brick to match existing.

[2] Rear Elevation - Timber cladding to new extension.


[3] Windows/ fenestrations - windows/ doors to be double glazed, aluminim finish.

[4] Flat roof to extension.

Drawing Title Proposed Elevations			Drawing Number 02P
Drawn: JC	Date	Revisions	Scale: 1:100 @
			A3

Dwg No: 04BC/R1 - General Details 1

0.1: Internal/ External Measurements 1:100

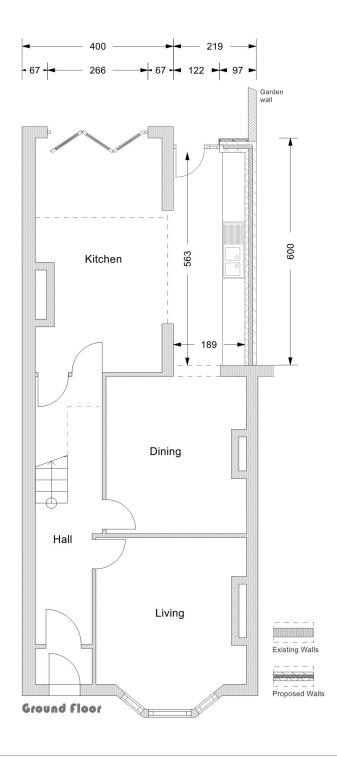


ALL TIMBER TO BE TREATED C16/ C24 UNLESS OTHERWISE STATED.

ALL FOUNDATIO DESIGN, STEELWORK, INTER-MEMBER CONNECTIONS, PADSTONES ETC, INSTALLED IN ACCORDANCE WITH THE STRUCTURAL ENGINEER'S NOTES/ DRAWINGS & TO THE APPROVAL OF THE BCO.

ALL LIGHTING, HEATING SERVICES & MECHANICAL VENTILATION TO COMPLY WITH THE 2013 EDITION 'DOMESTIC BUILDING SERVICES COMPLIANCE GUIDE'. COMMISSIONING CERTIFICATES SHOULD BE SUBMITTED TO THE BUILDING CONTROL OFFICER ON COMPLETION OF THE WORK.

FIRE ALARMS; COMMISSIONING CERTIFICATES SHOULD BE SUBMITTED TO THE BUILDING CONTROL OFFICER ON COMPLETION OF THE WORK

0.2: Lintels/ Beams 1:100

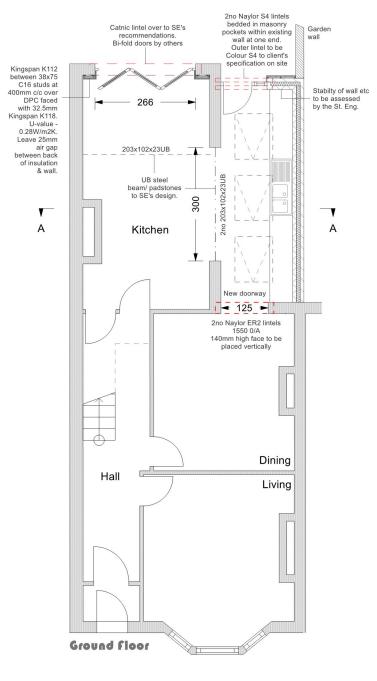

All lintels are to be securely built into masonry walls and be of the appropriate length to ensure a minimum bearing of 150mm at each end. All lintels are to have adequate load-bearing capacity appropriate to their position in the structure of the building.

A proprietary polyethene cavity tray shall be provided wherever the external cavity wall is bridged (ie, by doors, window openings etc), above all lintels, and over short piers between closely spaced openings. Cavity trays shall be provided with stop ends and proprietary perpends at a minimum of 2 per opening at a maximum of

The cavity tray shall project 25mm beyond the outer face of the cavity closer and overlap the ends of the lintel by 50-150mm (depending on the coursing of masonry) to allow the formation of an integral stop-end at a suitable perpend joint.

Returns to windows and door openings in the new cavity wall situated in conditioned spaces (habitable rooms) are to have vertical DPCs in the form of a proprietary cavity closers such as 'Thermabate' or similar.

0.3: Doors/ Cladding 1:100




Timber cladding to elevation of extension as detailed below

Masonry to the elevation is to be cut and angled to a line of around 10 degrees as shown to create the illusion of a pitched roof behind the parapet.

External doors by others. For details on fenestration/ ventilation, see 'Notes', right

0.4: Timber Cladding, Detail 1:50

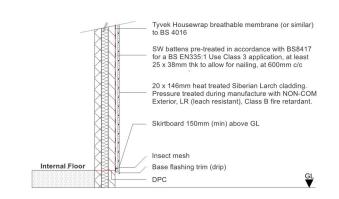

Cladding to be fixed taking into account shrinkage potential of timber species. Use only non-corrosive stainless steel, hot-dipped galvanised, or aluminium nails. Install all flashing and drips at windows heads, facsias etc as required.

ALL IN ACCORDANCE WITH THE MANUFACTURER'S INSTRUCTIONS & RECOMMENDATIONS.

Notes

1.0) FENESTRATION

Glazing to habitable rooms in conditioned spaces to be fitted with low e sealed double glazed units with a min U-value of 1.6 W/m2K (eg, Pilkington K Glass or similar). Centre pane value of 1.2 W/m2K or WER Band C (min). Doors >60% glass to have a minimum U-value of 1.6 W/m2K or a centre pane U-value of 1.2 W/m2K. DSER B and E (min). All windows and doors to be weather-stripped. Safety glazing in accordance with BS 6206 shall be fitted in the following critical locations:

(i) All glazed doors;(ii) All full height side lights;

(ii) Any window within 300mm from a door opening, up to a height of 1500mm; & (iv) Any window between finished floor level and 800mm above that level. The contractor shall be FENSA approved.

All fenestration to be safety glazed - glazing to door & windows to be Class C to BS6206 (min), (Note: no pane width proposed exceeds 900mm). Safe breakage to BS EN 12600 section 4/BS6202 clause 5.3

2.0) VENTILATION

Windows and patio doors are to provide minimum background ventilation via trickle vents to achieve 8000mm2 equivalent area (min) ventilation to the extension & adjoining Kitchen

11.0) MECHANICAL VENTILATION

Intermittent extract ventilation, manually controlled: To kitchen 30l/s adjacent to hob or 60l/s elsewhere with 15 minute over-run to exit via extension through ductwork through external wall to the outside. NOTE: ALL LIGHTING, HEATING SERVICES & MECHANICAL VENTILATION TO COMPLY WITH THE 2013 EDITION 'DOMESTIC BUILDING SERVICES COMPLIANCE GUIDE'. COMMISSIONING CERTIFICATES SHOULD BE SUBMITTED TO THE BUILDING CONTROL OFFICER ON COMPLETION OF THE

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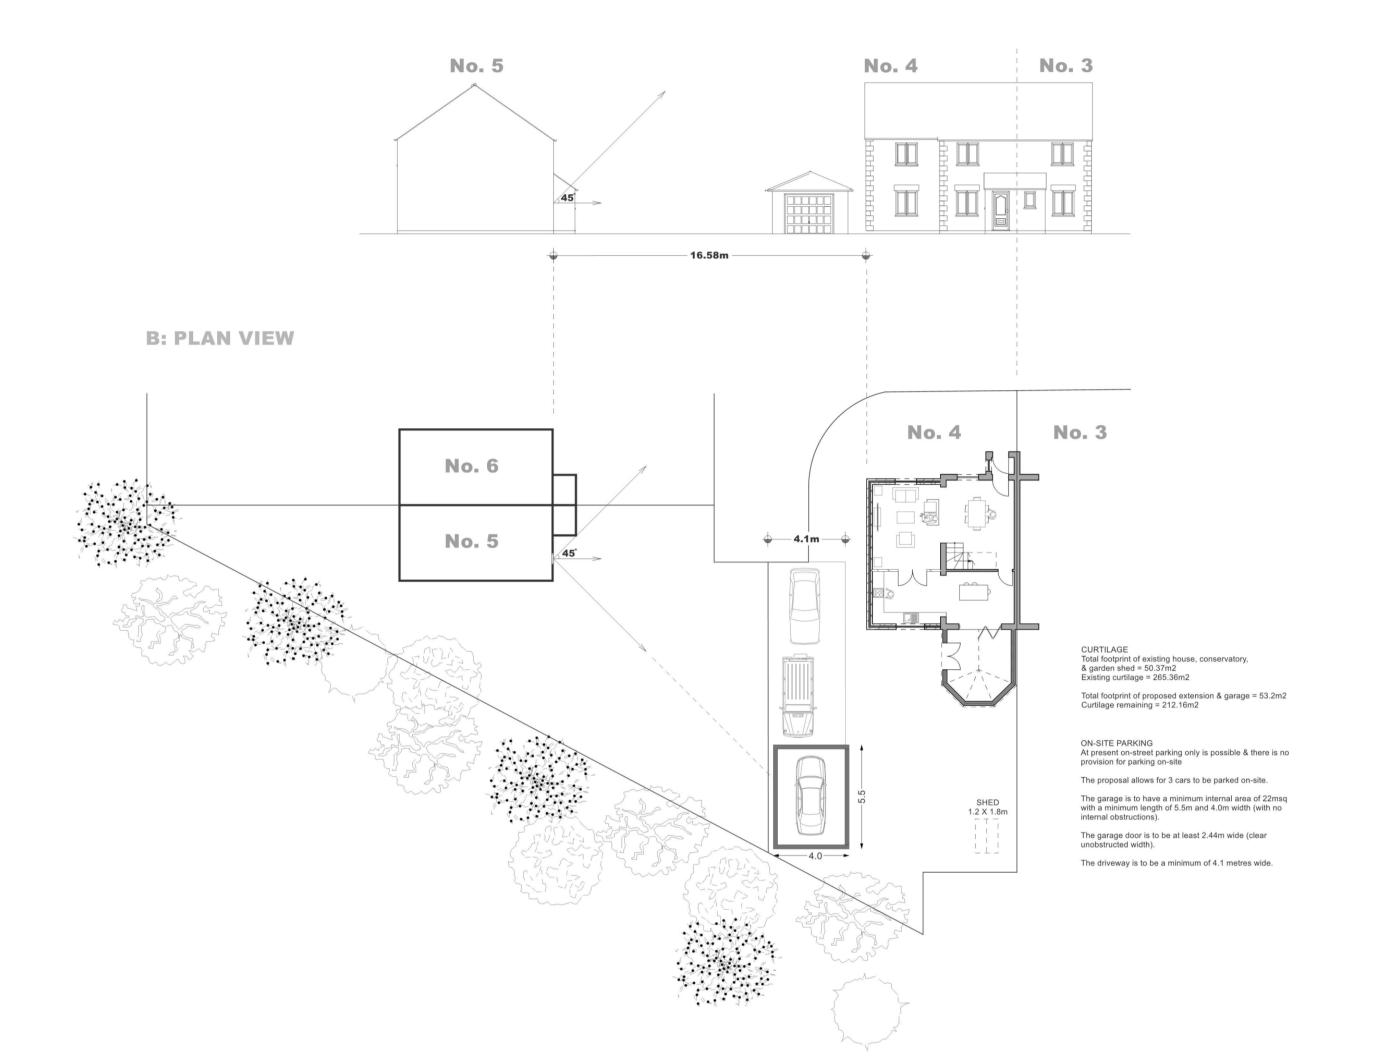


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			A3
Drawn: JC	Date	Revisions R1	Scale: Various @
Drawing Title General Det			Drawing Number 04BC
Project/ Clie	nt		
Project State PLANNING			Job Number 294-AB

PROPOSED 0:5


A: ELEVATION VIEW





1:200



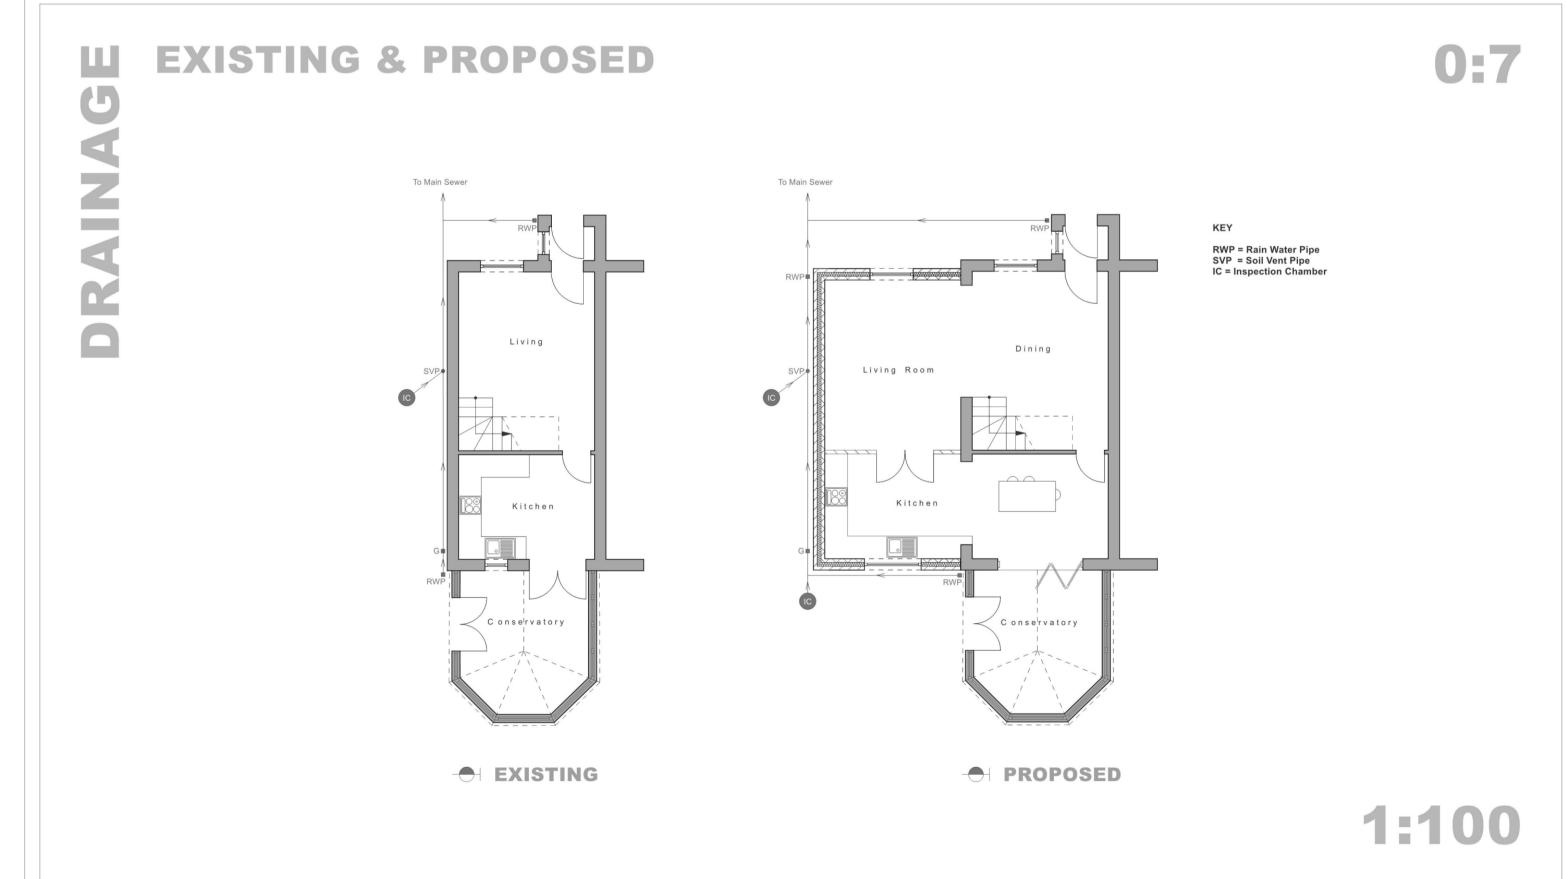



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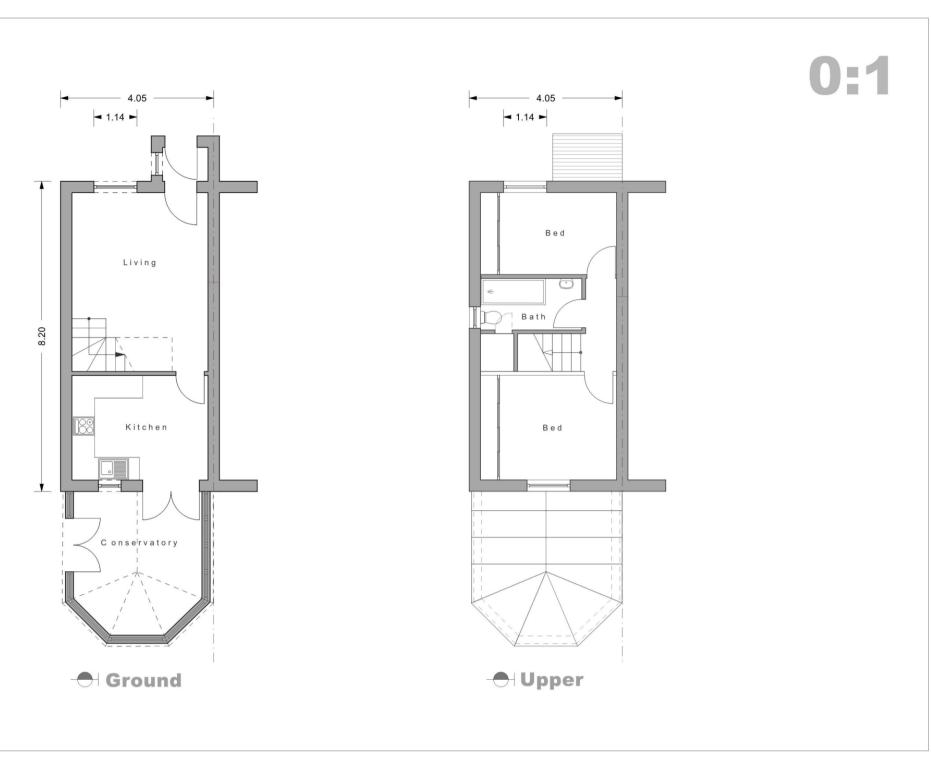
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NOTES

ROOF COVERINGS, MASONRY, WINDOWS, EXPOSED LINTELS, & QUOINS ETC TO MATCH EXISTING.


Project Status PLANNING DRAWI Project/ Client	NG		Job Number 284-AB
Drawing Titile GENERAL DETAIL	S		Drawing Number 02/P
Drawn JC	Date	Revisions	Various

DWG NO: 01/P - EXISTING & PROPOSED FLOOR PLANS AND ELEVATIONS







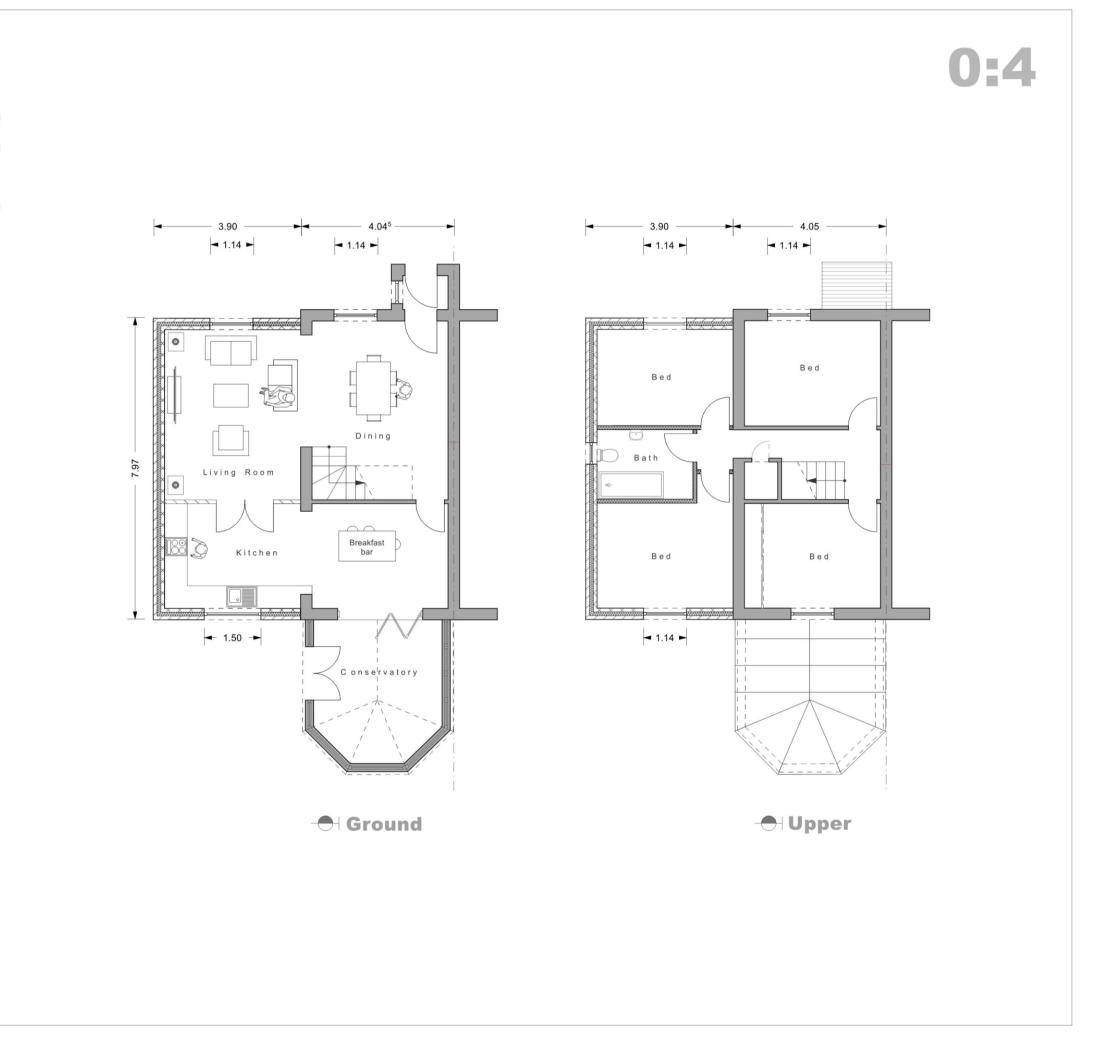



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NOTES

ROOF COVERINGS, MASONRY, WINDOWS, EXPOSED LINTELS, & QUOINS ETC TO MATCH EXISTING.

Project Status PLANNING DRAWING			Job Number 284-AB	
Drawing Titile EXISTING & PROPOSED PLANS/ ELEVATIONS			Drawing N 01/P	lumber
Drawn	Date	Revisions	Scale	1:100
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Dwg No: 01P - Existing & Proposed Floor Plans/ Elevations, 1:100/ A1







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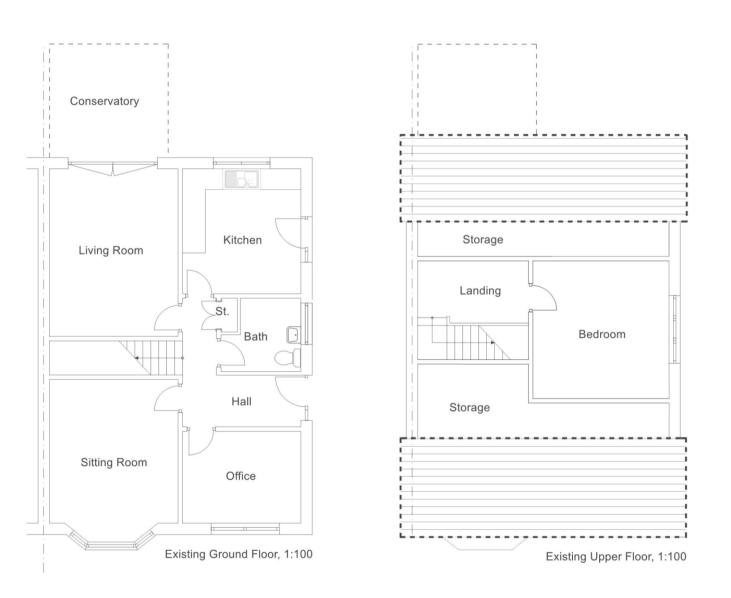
Project Status: PLANNING DRAWING Drawing Title: EXISTING & PROPOSED

Job Number 368-AB

Drawing Number 01P

Revision Scale: 1:100 Drawn: JC @ A1








1. Soldier course of facing brick above openings.

2. Render front & sides of extension.


3. Facing brickwork where seen above ground.

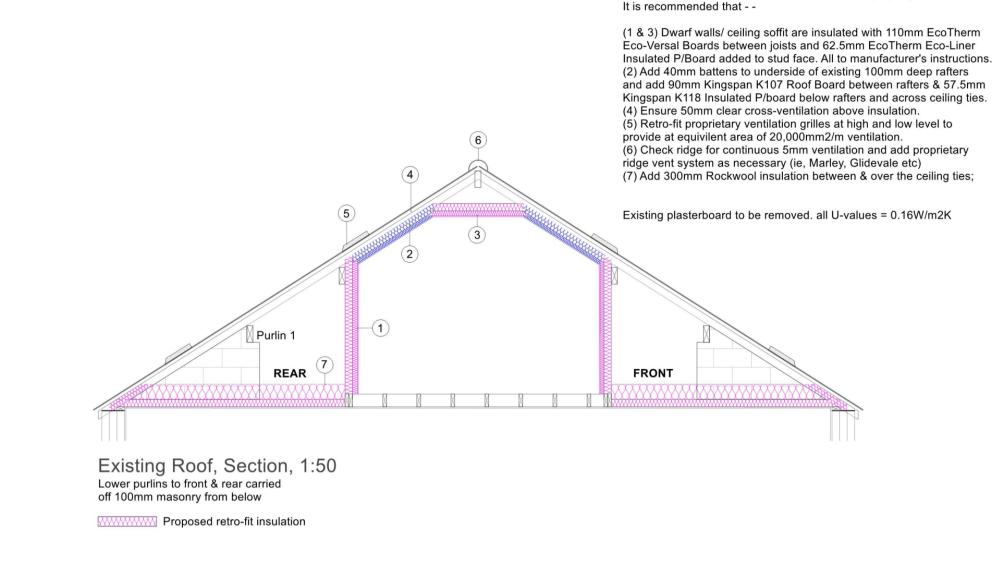


INSULATION & VENTILATION TO EXISTING LOFT CONVERSION


The present loft conversion is uninsulated & not properly ventilated.

D1 - A: Plan of Proposed Roof Layout, 1:50

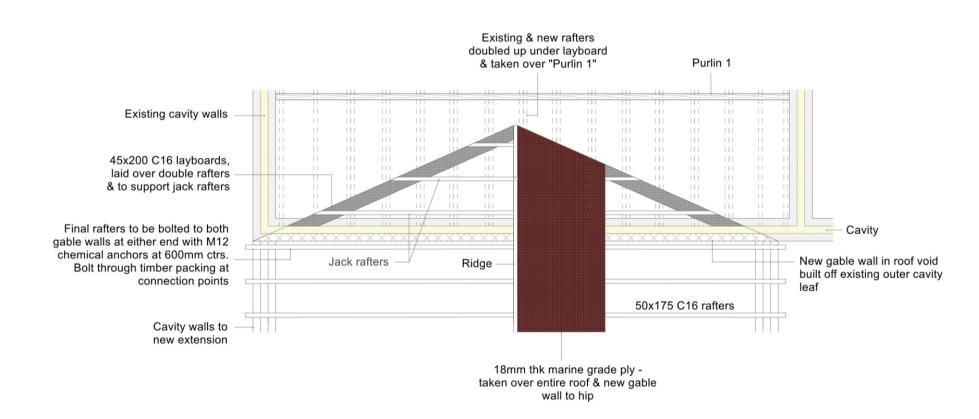

D1 - B: Section of Proposed Roof Layout, 1:20

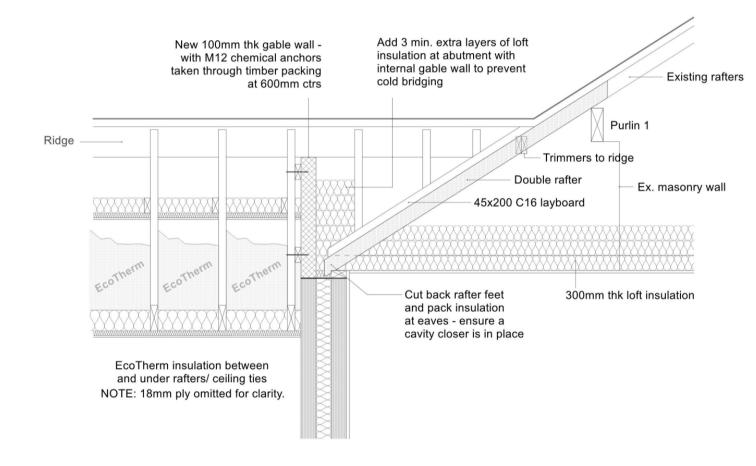

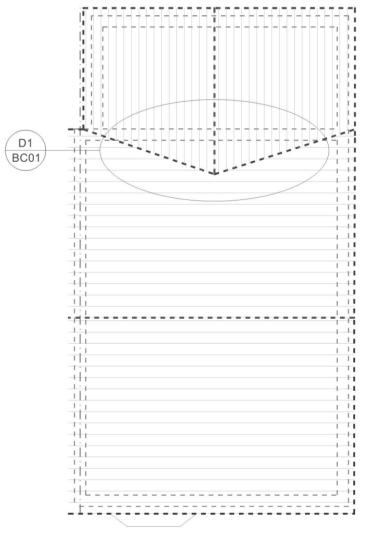

Proposed Roof, 1:100

1.1) Pitched Roof Coverings

Covering to be concrete plain tiles to match existing in colour. Capping, verge/eaves details fixed in accordance with manufacturer's

Cladding to be fixed to a minimum 25 x 50mm treated timber battens & counter batterns or to manufacturer's directions. Rafters to be overlaid with untearable breathable felt underlay to BS 747 or relevant BBA certificate (low vapour resistance - eg, Nilvent or similar). Where felt is exposed at eaves use UV resistant or type 5U felt or a proprietary eaves guard.

2.0) DUO-PITCHED ROOF

Form as a warm deck, collar roof, 15 degree pitch, as follows:

(A) COVERING - Concrete plain tiles (Sandtoft 20/20 or similar) to match existing. (B) MEMBRANE – use breathable felt, Nilvent or similar taken down roof slope and lapped 50mm into gutter, all to manufacturer's

(C) SHEATHING - Nail 18mm plywood sheathing over rafters to provide stability to roof & fix to gable ends with M12 chemical anchors at 600mm ctrs. Bolt through timber packing at connection points.

(D) RAFTERS - C24 50x170mm at 400mm ctrs birdsmouthed over 50 x 100mm C24 wallplate. (E) INSULATION - 125mm EcoTherm Eco-Versal Boards between joists. Maintain 50mm air gap between the top of the insulation

and the plywood sheathing. 52.5mm EcoTherm Eco-Liner insulated plasterboard below joists. Skim plaster.

U-value of roof = 0.15W/m2K


2.1) Roof Restraint

Roof and walls to be provided with lateral restraint straps across at least 3 timbers wall plate and verge levels with 30 x 5mm x 1m galvanized metal straps or other approved to BSEN 845-1 at maximum 2m centres.

Lead work, flashing, soakers, valleys, and gutters, etc, to be formed from Code 5 lead sheet, to have a minimum 150mm lap joints, dressed 200mm under tiles, etc, and not to be fixed in lengths exceeding 1.5m and to be fixed in accordance with the roof cladding manufacturers and the Lead Development Association recommendations.



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THE SATISFACTION OF THE BCO BEFORE WORK BEGINS ON SITE. FOUNDATION DEPTHS TO THE SATISFACTION OF THE BCO. ALL LIGHTING, HEATING SERVICES & MECHANICAL VENTILATION TO COMPLY WITH THE 2013 EDITION 'DOMESTIC BUILDING SERVICES COMPLIANCE GUIDE'.COMMISSIONING CERTIFICATES SHOULD BE SUBMITTED TO THE BUILDING CONTROL OFFICER ON COMPLETION OF THE WORK.
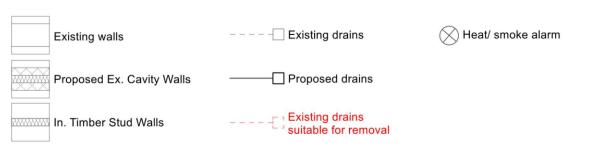
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330-AB Drawing Number 01BC

Job Number

Scale: Various @ A1


Structure and measurements should be checked on site by the appointed engineer. Drawn: JC April 2022 Existing Elevations & Floor Plans


Proposed Elevations & Floor Plans




LEFT



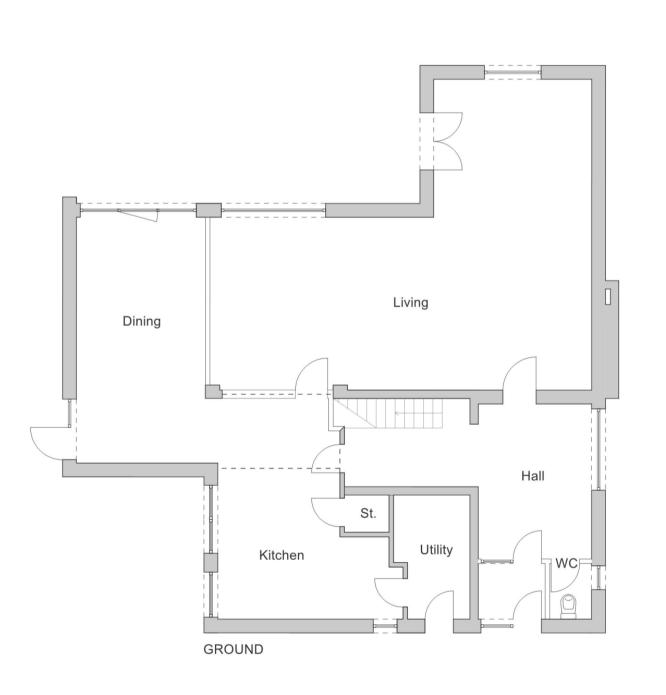

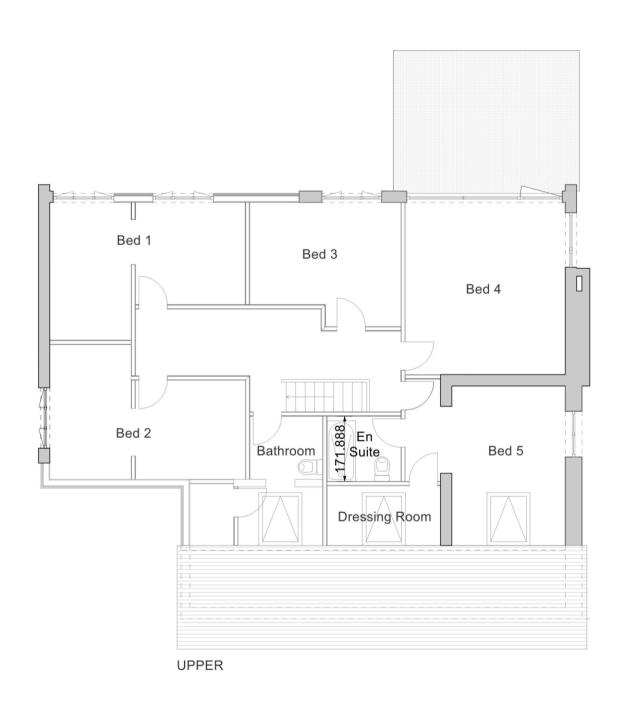

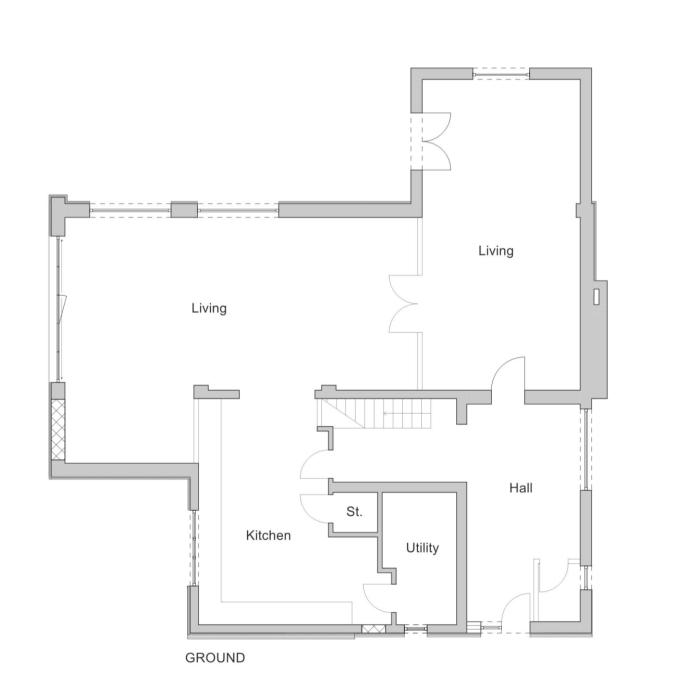

OF THE WORK.



NOTES

1. The house is a partially timber framed structure & a degree of loading from the roof sits on internal timber load-carrying walls. A full structural assessment should be carried out by a St. Engineer before work begins on site.

2. The proposed bi-fold doors to the left elevation are sited within a partially free standing wall - the proposed new masonry will tie this wall into the existing structure, however this wall is to be assessed by the St. Eng. before work begins on site.

All to the satisfaction of the BCO.



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Existing Materials
Walls: timber cladding and render
Roof: Concrete tiles
Glazing/ Doors: mixture of wood and white uPVC

Proposed Materials
Walls: timber cladding and render
Roof: Concrete tiles
Glazing/ Doors: DG aluminium, graphite in colour


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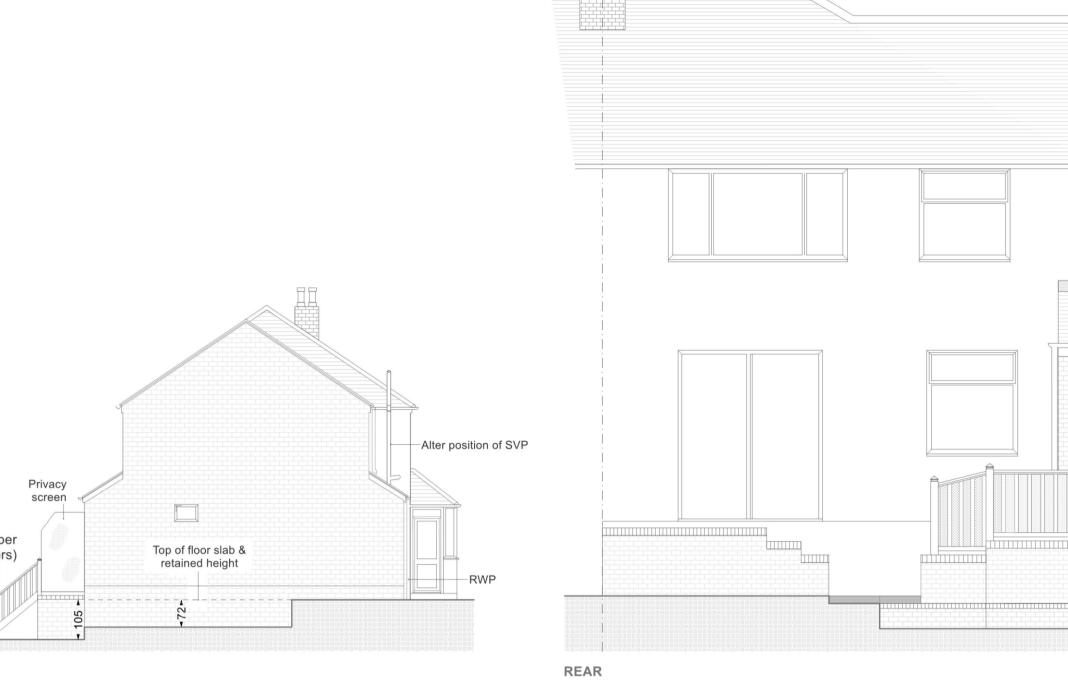
DETAILS RELATING TO ANY STEELWORK TO THE DESIGN OF CONSULTING STRUCTURAL ENGINEER. TO BE SUBMITTED TO THE SATISFACTION OF THE BCO BEFORE WORK BEGINS ON SITE. FOUNDATION DEPTHS TO THE SATISFACTION OF THE BCO.


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FIRE ALARMS: COMMISSIONING CERTIFICATES SHOULD BE SUBMITTED TO THE BUILDING CONTROL OFFICER ON COMPLETION

		Job Number 425-AB
		Drawing Number 01BC
wn: JC	Revision	Scale: 1:100 @





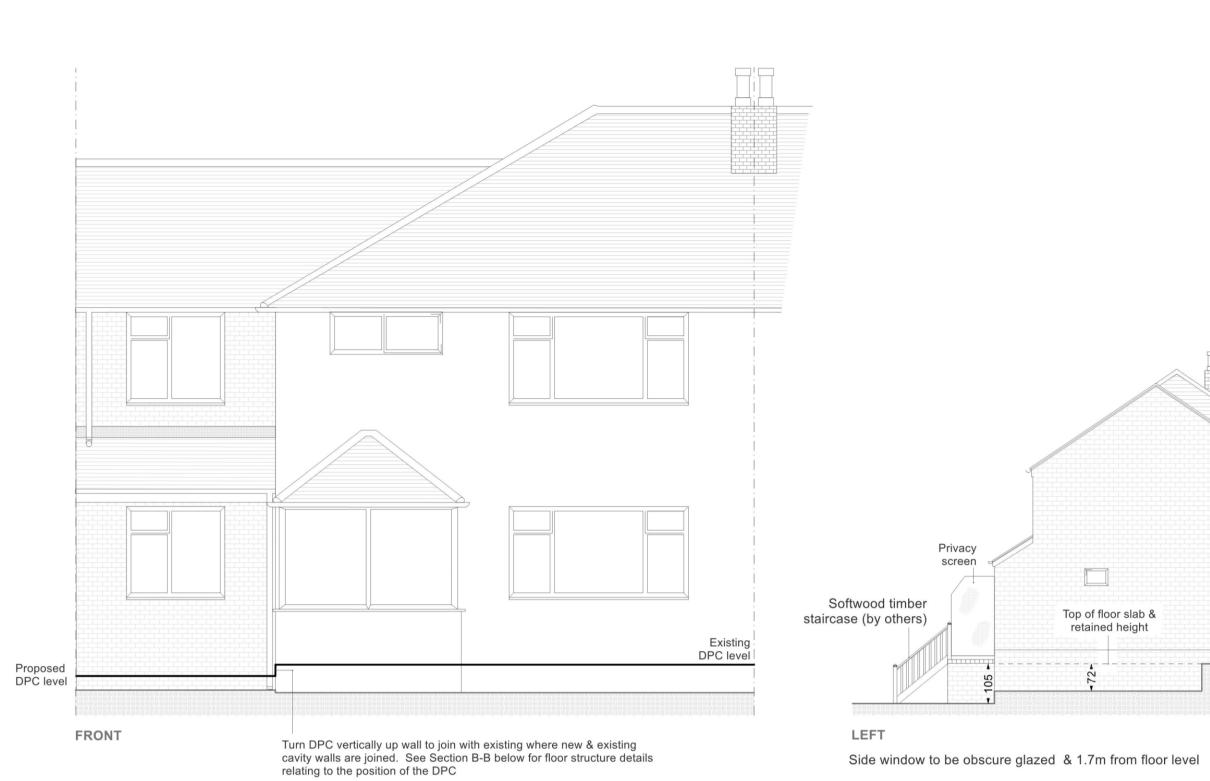

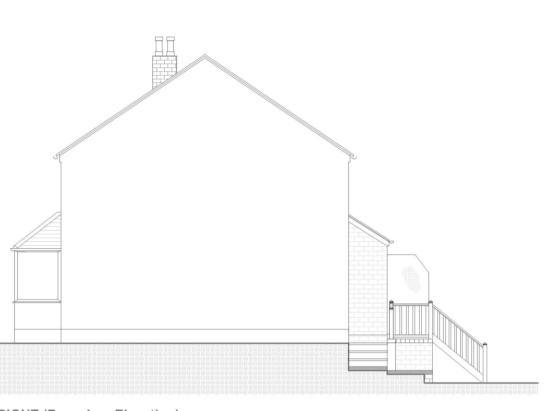
RIGHT (Boundary Elevation)





Allow enough space to fit RWP to the front elevation of the extension at ground floor level. Connect the porch gutter into RWP.

Existing Elevations

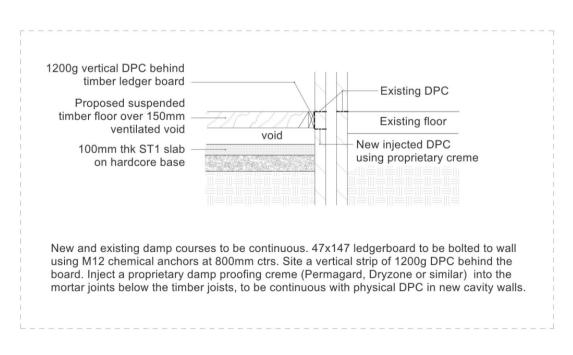

Section B-B 1:20
Position of new & existing DPCs



Proposed Elevations

NOTES
Facing brickwork, roof tiles, windows & doors,
all to match existing



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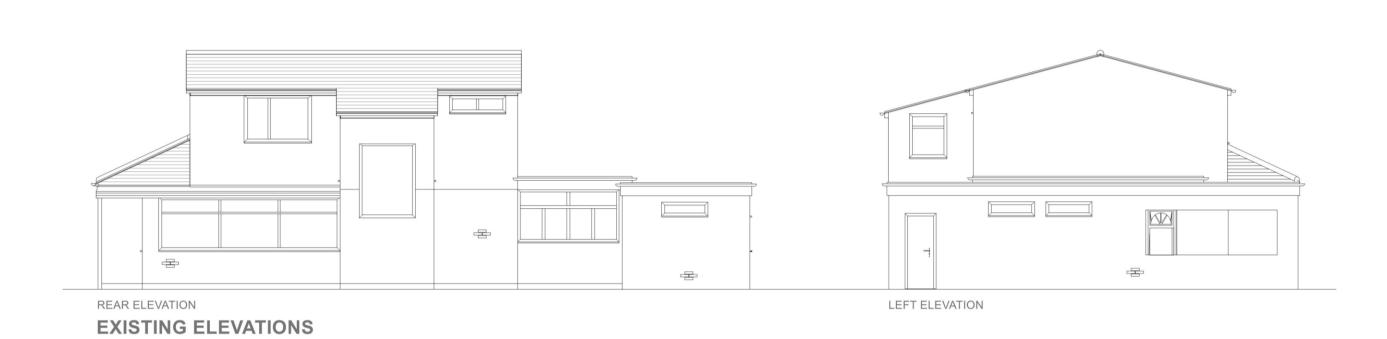
Project Status: BC DRAWING

Drawing Title: PROPOSED/ EXISTING ELEVATIONS


Drawing Number 01BC


Drawn: JC Date Revision Scale: 1:20/ 1:50/ 1:100 @ A1









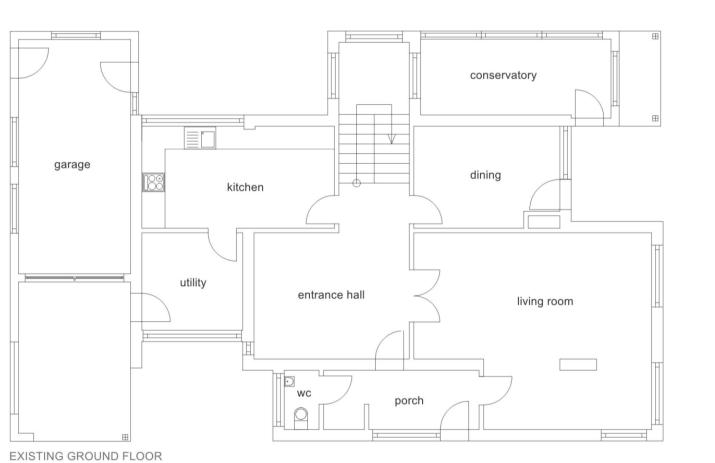

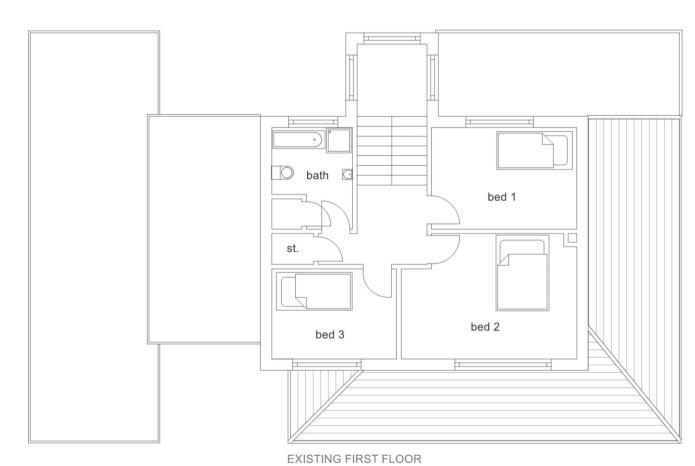

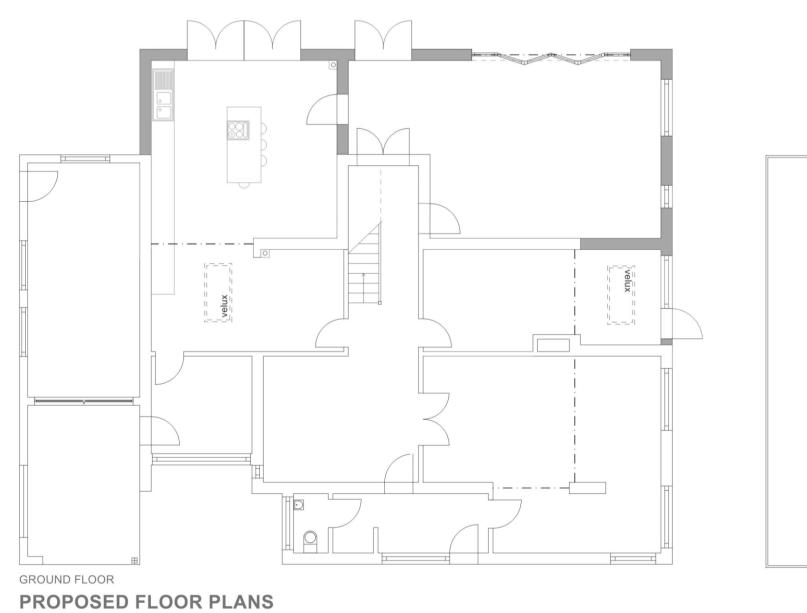

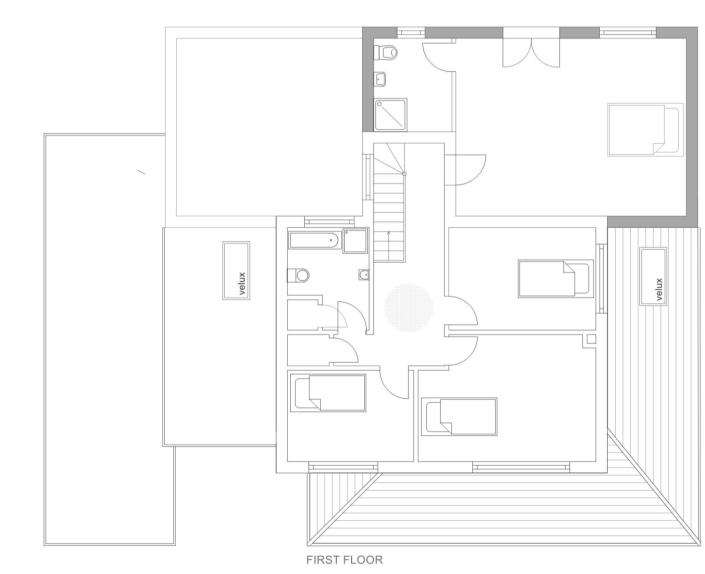

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		Job Number 262-AB
		Drawing Number 01BCR1
Date uly 2022	Revision R1	Scale: 1:100 @ A1

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EXISTING FLOOR PLANS